
CITY OF ALBANY

ALBANY MUNICIPAL AIRPORT


AWOS-III P/T IMPROVEMENTS

AIP NO. 3-41-0001-017-2021

VICINITY MAP

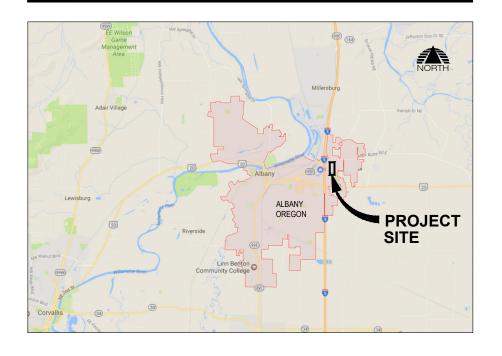

PROJECT MAP

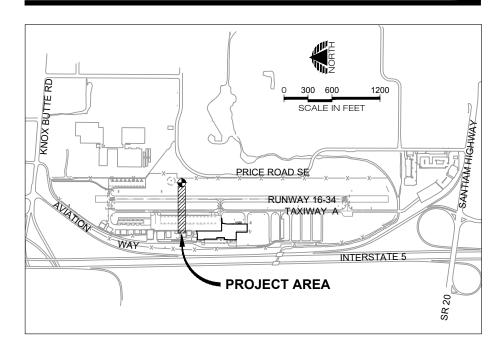

INDEX TO DRAWINGS

- **COVER SHEET**
- LEGEND AND BID SCHEDULE
- SITE PLAN
- CONSTRUCTION PLAN PROJECT SPECIFIC CRITICAL AREAS
- **CONSTRUCTION PLAN PHASE 1**
- **CONSTRUCTION PLAN PHASE 2**
- CONSTRUCTION PLAN GENERAL NOTES AND DETAILS
- AWOS LAYOUT PLAN
- AWOS INSTALLATION DETAILS
- **ELECTRICAL DETAILS**
- 11 **ELECTRICAL DETAILS**
- 12 **ELECTRICAL DETAILS**

Precision Approach ENGINEERING 5125 Southwest Hout Street Corvallis, OR 97333



SCALE: AS SHOWN REVISIONS: APPD. DATE

DATE: MAR 2021 DESIGN: GWV DRAWN: JAW CHECKED: **GWV** REVISION NUMBER:

AWOS-III P/T IMPROVEMENTS

ALBANY MUNICIPAL AIRPORT

COVER SHEET

PRECISION APPROACH ENGINEERING, INC. AIP NO. 3-41-0001-017-2021

PROJECT NUMBER: ALB006

SHEET NO.

OF **12**

THIS DRAWING IS INTENDED TO BE PRINTED IN COLOR. PRINTING IN BLACK AND WHITE MAY REDUCE READABILITY AND ALTER ENTITY DEFINITION OR REPRESENTATION.

BASE BID SCHEDULE

| BID ITEM NUMBER | DESCRIPTION | UNIT | ESTIMATED QUANTITY | CONSTRUCTION QUANTITY |
|--------------------|---------------------------------|------|--------------------|-----------------------|
| 1 | CONSTRUCTION SURVEY AND STAKING | LS | 1 | |
| 2 | TEMPORARY EROSION CONTROL | LS | 1 | |
| 3 | MOBILIZATION | LS | 1 | |
| 4 | DEMOLITION | LS | 1 | |
| 5 | AWOS-III P/T | LS | 1 | |
| 6 | WIND DIRECTION MONUMENTATION | LS | 1 | |
| 7 | GEOTEXTILE FABRIC | SY | 140 | |
| 8 | CRUSHED AGGREGATE BASE | SY | 140 | |
| 9 | NO. 8 AWG, 5KV, L-824C CABLE | LF | 2,090 | |
| 10 | AWOS POWER SUPPLY | LS | 1 | |
| 11 | ELECTRICAL TRENCH, NON-PAVED | LF | 220 | |
| 12 | 2-INCH PVC CONDUIT | LF | 200 | |
| 13 | 3-INCH PVC CONDUIT | LF | 40 | |
| 14 | ELECTRICAL HANDHOLE | EA | 2 | |
| | | | | |

LEGEND

CIVIL SYMBOLS LEGEND


| EXISTING | NEW | |
|------------------|----------------|------------------------|
| | | EDGE OF PAVEMENT |
| | | EDGE OF GRAVEL |
| . —— 101.8 — — — | 101 | CONTOUR |
| | | DITCH FLOW LINE |
| _ x x | xx | FENCE |
| spsp- | sDsD | STORM DRAIN |
| UD | | UNDER DRAIN |
| | > | CULVERT |
| ssss- | ssss | SANITARY SEWER |
| -ww | w | WATER |
| G | G | GAS |
| t | | TELEPHONE |
| ——IRR——— | IRR | IRRIGATION |
| | — | SLOPE SYMBOL |
| | | CATCH BASIN |
| SD | (SD) | STORM DRAIN MANHOLE |
| 0 | 0 | CLEANOUT |
| | | CULVERT END STRUCTURE |
| ~~> | ~~ > | SURFACE FLOW DIRECTION |
| (§\$) | SS | SANITARY MANHOLE |
| \forall | A | FIRE HYDRANT |
| W | W | WATER METER |
| W | W | WATER VAULT |
| \otimes | \otimes | WATER VALVE |
| \otimes | \otimes | IRRIGATION VALVE |
| 0 | 0 | TIE DOWN |
| þ | þ | SIGN |
| Â | | SURVEY CONTROL POINT |
| • | • | SURVEY FOUND MONUMENT |
| 0 | | BRASS CAP |
| • | • | BENCHMARK |
| ★ | ⊗ | AIRPORT BEACON |
| | | SHRUBS |
| · Sally | | TREES |
| | | ABANDONED FEATURE LINE |
| xxxxxxxx · | | DEMO FEATURE LINES |

| ELE | CTI | RICA | ۱ J۶ | EG | END |
|-----|-----|------|------|----|-----|
|-----|-----|------|------|----|-----|

| EXISTING | NEW | |
|-------------------------|------------|---|
| НН | H | HANDHOLE |
| Р | Р | POWER VAULT |
| DM | DM | DUCT MARKER |
| | ① | JUNCTION CAN |
| Œ> | Œ. | ELECTRICAL RISER |
| * | ※ ☀ | RUNWAY EDGE LIGHT AND THRESHOLD LIGHT C = CLEAR R = RED G = GREEN Y = YELLOW O = OPAQUE |
| 斑 | 斑 | RUNWAY LIGHT IN PAVEMENT (FLUSH MOUNT) |
| | \Box | REIL (RUNWAY END IDENTIFIER LIGHT) |
| | | PAPI (PRECISION APPROACH PATH INDICATOR) |
| | - - | TAXIWAY LIGHT (BLUE LENS) |
| <u></u> | P | TAXIWAY LIGHT IN PAVEMENT (FLUSH MOUNT) |
| 0 | 0 | RETROREFLECTIVE MARKER |
| — — РОН— — — | ———POH——— | POWER CIRCUIT / OVERHEAD |
| | P | POWER UNDERGROUND |
| · -0- | o -o- | POWER POLE |
| (— | (| GUY WIRE |
| ∞ - \ | <u>~</u> ₩ | STREET LIGHT |
| | | GUIDANCE SIGN |





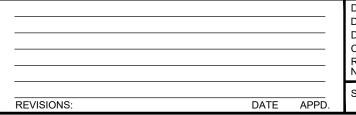

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LEGEND AND BID SCHEDULE


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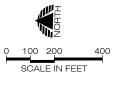
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NUMBER: 0

SCALE: AS SHOWN PRECISION APPROACH ENGINEERING, INC. AIP NO. 3-41-0001-017-2021





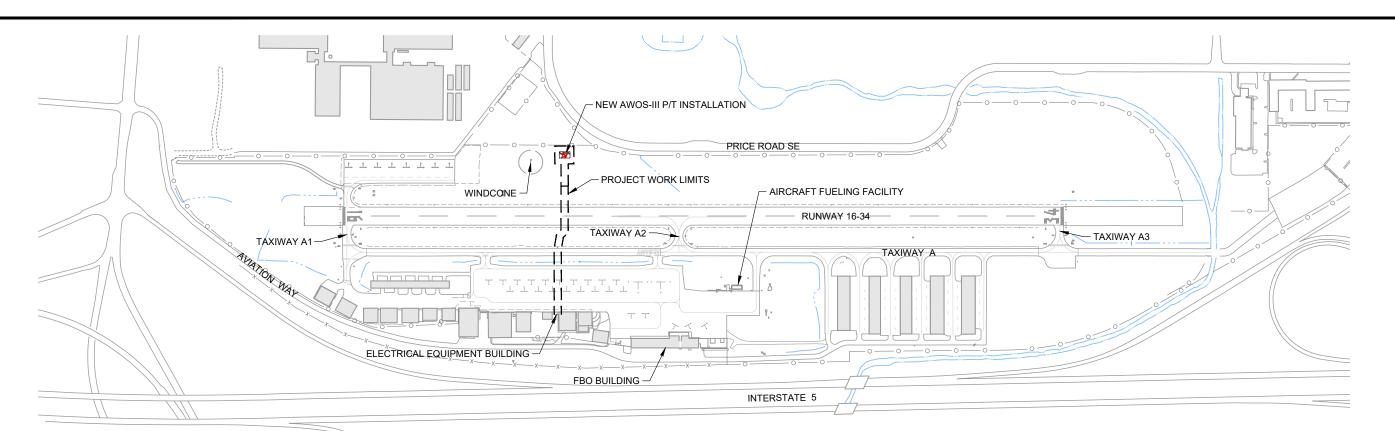

EROSION AND SEDIMENT CONTROL NOTES:

- 1. BEST MANAGEMENT PRACTICES (BMPs) FOR TEMPORARY EROSION AND SEDIMENT CONTROL SHALL BE IMPLEMENTED AND MAINTAINED UNTIL SITE IS STABILIZED.
- 2. THE CONTRACTOR IS RESPONSIBLE FOR ALL MEASURES REQUIRED BY THE CONTRACTORS MEANS AND METHODS OF CONSTRUCTION TO CONTROL EROSION AND SEDIMENT AT THE CONSTRUCTION SITE. IT IS THE CONTRACTORS RESPONSIBILITY TO PREVENT A VIOLATION OF SURFACE WATER QUALITY, GROUND WATER QUALITY, OR SEDIMENT MANAGEMENT STANDARDS. THE CONTRACTOR SHALL COMPLY WITH ALL APPLICABLE FEDERAL, STATE, AND LOCAL LAWS, ORDINANCES AND STANDARDS.
- 3. PUBLIC RIGHT-OF-WAY AND AIRCRAFT OPERATIONS AREAS SHALL BE KEPT IN A CLEAN AND SERVICEABLE CONDITION AT ALL TIMES. IN THE EVENT MATERIALS ARE INADVERTENTLY DEPOSITED ON ROADWAYS, TAXIWAYS, TAXILANES OR APRONS THE MATERIAL SHALL BE PROMPTLY REMOVED.
- CONTRACTOR SHALL USE ALL MEANS NECESSARY TO MINIMIZE DUST DURING CONSTRUCTION. IF THE ENGINEER REQUESTS DUST CONTROL, THE CONTRACTOR SHALL COMPLY IMMEDIATELY.
- THE CONTRACTOR SHALL HAVE SWEEPING OR VACUUMING CAPABILITIES IN ORDER TO REMOVE DEBRIS FROM ACTIVE OPERATIONAL AREAS. MATERIALS TRACKED ONTO THESE AREAS MUST BE CONTINUOUSLY REMOVED DURING THE PROJECT.
- 6. CONTRACTOR SHALL INSTALL AGGREGATE CONSTRUCTION ENTRANCE AND CONCRETE WASHOUT FACILITY, VERIFY LOCATION WITH ENGINEER PRIOR TO INSTALLATION.
- 7. SEED AND MULCH ANY AREAS DISTURBED BY CONSTRUCTION ACTIVITIES. ALL SEEDING AND MULCHING COSTS SHALL BE PAID FOR UNDER THE TEMPORARY EROSION CONTROL BID ITEM. CONTRACTOR SHALL PROVIDE SEED MIX TO ENGINEER FOR REVIEW AND APPROVAL PRIOR TO PLACEMENT

CONSTRUCTION SCHEDULE:

- 1. THE CONTRACTOR SHALL PREPARE AND SUBMIT A "CONSTRUCTION SAFETY PLAN COMPLIANCE DOCUMENT" AND "CONSTRUCTION SCHEDULE" TO THE ENGINEER AND OWNER FOR REVIEW A MINIMUM OF 10 DAYS PRIOR TO STARTING CONSTRUCTION OR PRIOR TO THE PRE-CONSTRUCTION CONFERENCE, WHICHEVER OCCURS EARLIER. THE PLAN MUST BE ACCEPTABLE TO THE OWNER PRIOR TO BEGINNING WORK.
- THE CONSTRUCTION SCHEDULE SHALL BE REVISED ANY TIME AN ELEMENT OF WORK DOES NOT COINCIDE WITH THE INITIAL TIME LINE PRESENTED OR IF REQUESTED BY THE ENGINEER OR OWNER.

GENERAL NOTES:

- THE CONTRACTOR'S ATTENTION IS DIRECTED TO THE GENERAL CONTRACT PROVISIONS, TECHNICAL SPECIFICATIONS AND CONSTRUCTION SAFETY AND PHASING PLAN SECTIONS OF THE CONTRACT DOCUMENT FOR REQUIREMENTS RELATING TO CONSTRUCTION SAFETY, LAYOUT WORK, QUALITY CONTROL TESTING AND OTHER CONTRACT PROVISIONS.
- 2. THE CONTRACTOR, ENGINEER, OWNER, AND OTHER INVITED REPRESENTATIVES OR GUESTS WILL CONDUCT A PRE-CONSTRUCTION MEETING PRIOR TO BEGINNING CONSTRUCTION IN ORDER TO DISCUSS PROJECT SCHEDULE, CONSTRUCTION REQUIREMENTS, AIRFIELD IMPACTS, AND OTHER AGENDA ITEMS RELATED TO THE PROJECT.
- 3. THE CONTRACTOR SHALL OBTAIN AND THE OWNER WILL PAY FOR ANY PERMITS, FEES, OR CHARGES NECESSARY TO COMPLETE THIS PROJECT.
- 4. THE CONTRACTOR SHALL BE RESPONSIBLE TO LOCATE AND PROTECT ALL UTILITIES DURING THIS PROJECT. THE CONTRACTOR SHALL BE RESPONSIBLE FOR CALLING THE UTILITY NOTIFICATION CENTER TO LOCATE PUBLIC UTILITIES AND FOR ANY ADDITIONAL UTILITY LOCATES INCLUDING HIRING A PRIVATE LOCATE SERVICE IF REQUIRED. ANY UTILITIES DAMAGED IN CONJUNCTION WITH THE CONSTRUCTION ACTIVITIES SHALL BE REPLACED AND/OR REPAIRED BY THE CONTRACTOR AS APPROVED BY THE OWNER.
- 5. ALL HAUL ROUTES SHALL BE MAINTAINED DURING CONSTRUCTION AND SHALL BE RESTORED TO ORIGINAL CONDITION BY THE CONTRACTOR UPON COMPLETION OF THE PROJECT. VERIFY CONDITION WITH OWNER PRIOR TO CONSTRUCTION. RESTORATION AND GRADING OF GRAVEL ACCESS ROADS SHALL BE CONDUCTED UPON COMPLETION OF USE BY THE CONTRACTOR.
- 6. LIMITS OF WORK SHOWN ON THIS SHEET ARE APPROXIMATE AND SHOW GENERAL AREAS OF WORK. SEE SPECIFIC SHEETS FOR ACTUAL LIMITS OF WORK.

PROJECT FUNDING:

- 1. EXECUTION OF ALL WORK IN THIS CONTRACT IS CONTINGENT UPON THE CITY OF ALBANY'S RECEIPT OF FEDERAL FUNDS. THESE FUNDS WILL NOT BE ASSURED UNTIL A GRANT IS EXECUTED BETWEEN THE FAA AND THE CITY OF ALBANY AFTER THE CONTRACT BID OPENING. GRANT EXECUTION IS EXPECTED TO OCCUR IN THE LATE SPRING/ EARLY SUMMER OF 2021. OWNER SHALL HAVE THE FINAL AUTHORITY REGARDING START DATE OF CONSTRUCTION.
- 2. ALL ELEMENTS OF WORK ARE AIRPORT IMPROVEMENT PROGRAM (AIP) ELIGIBLE.

CONTRACTOR'S SUPERINTENDENT AND SAFETY OFFICER:

- THE CONTRACTOR SHALL HAVE A FULL TIME SUPERINTENDENT ON THE PROJECT SITE ANY TIME WORK IS BEING ACCOMPLISHED ON THE AIRPORT. THIS INCLUDES WORK BEING PERFORMED BY SUBCONTRACTORS OR SERVICE PROVIDERS UNLESS OTHERWISE APPROVED BY THE OWNER.
- 2. THE CONTRACTOR SHALL ASSIGN ONE PERSON TO BE THE SAFETY OFFICER DURING THE PROJECT. THE SAFETY OFFICER SHALL BE ONSITE AT ALL TIMES WHEN WORK IS OCCURRING IN THE AIR OPERATIONS AREA (AOA) WHEN THE AIRPORT IS OPEN UNLESS OTHERWISE APPROVED BY THE OWNER. THE SAFETY OFFICER SHALL BE RESPONSIBLE FOR THE EDUCATION AND TRAINING OF ALL PERSONNEL WHO WILL ACCESS AIRPORT PROPERTY. THE OFFICER SHALL MAINTAIN RECORDS INDICATING THAT PERSONNEL HAVE BEEN TRAINED AND ARE FAMILIAR WITH SAFETY RULES AND REGULATIONS RELATED TO OPERATIONS AT THE AIRPORT DURING CONSTRUCTION. PERSONNEL WHO VIOLATE SAFETY REQUIREMENTS MAY BE REMOVED FROM THE PROJECT AT THE DISCRETION OF THE OWNER. THE SAFETY OFFICER SHALL ALSO BE RESPONSIBLE FOR FOREIGN OBJECT DEBRIS (FOD) MANAGEMENT. SEE CONSTRUCTION SAFETY AND PHASING PLAN FOR ADDITIONAL REQUIREMENTS
- 3. THE CONTRACTOR'S SUPERINTENDENT AND SAFETY OFFICER SHALL ATTEND THE WEEKLY CONSTRUCTION MEETING.

WEEKLY CONSTRUCTION MEETING:

1. THE CONTRACTOR, ENGINEER, RPR, OWNER, OWNER'S REPRESENTATIVE AND OTHER INVITED REPRESENTATIVES OR GUESTS WILL CONDUCT A WEEKLY CONSTRUCTION MEETING IN ORDER TO DISCUSS ACTIVITIES ON THE PROJECT. THE MEETING SHALL BE USED TO DISCUSS CONSTRUCTION ISSUES, PROJECT SCHEDULE, AND AIRPORT OPERATIONS DURING CONSTRUCTION AND OTHER AGENDA ITEMS RELATED TO THE PROJECT. SPECIFIC ACTIVITIES ANTICIPATED FOR THE FOLLOWING WEEK SHALL BE DISCUSSED, PARTICULARLY THOSE IMPACTING AIRPORT OPERATIONS AND SAFETY. A TWO WEEK LOOK AHEAD SHALL ALSO BE PROVIDED.





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ALBANY MUNICIPAL AIRPORT AWOS-III P/T IMPROVEMENTS

SITE PLAN

PRECISION APPROACH ENGINEERING, INC. AIP NO. 3-41-0001-017-2021


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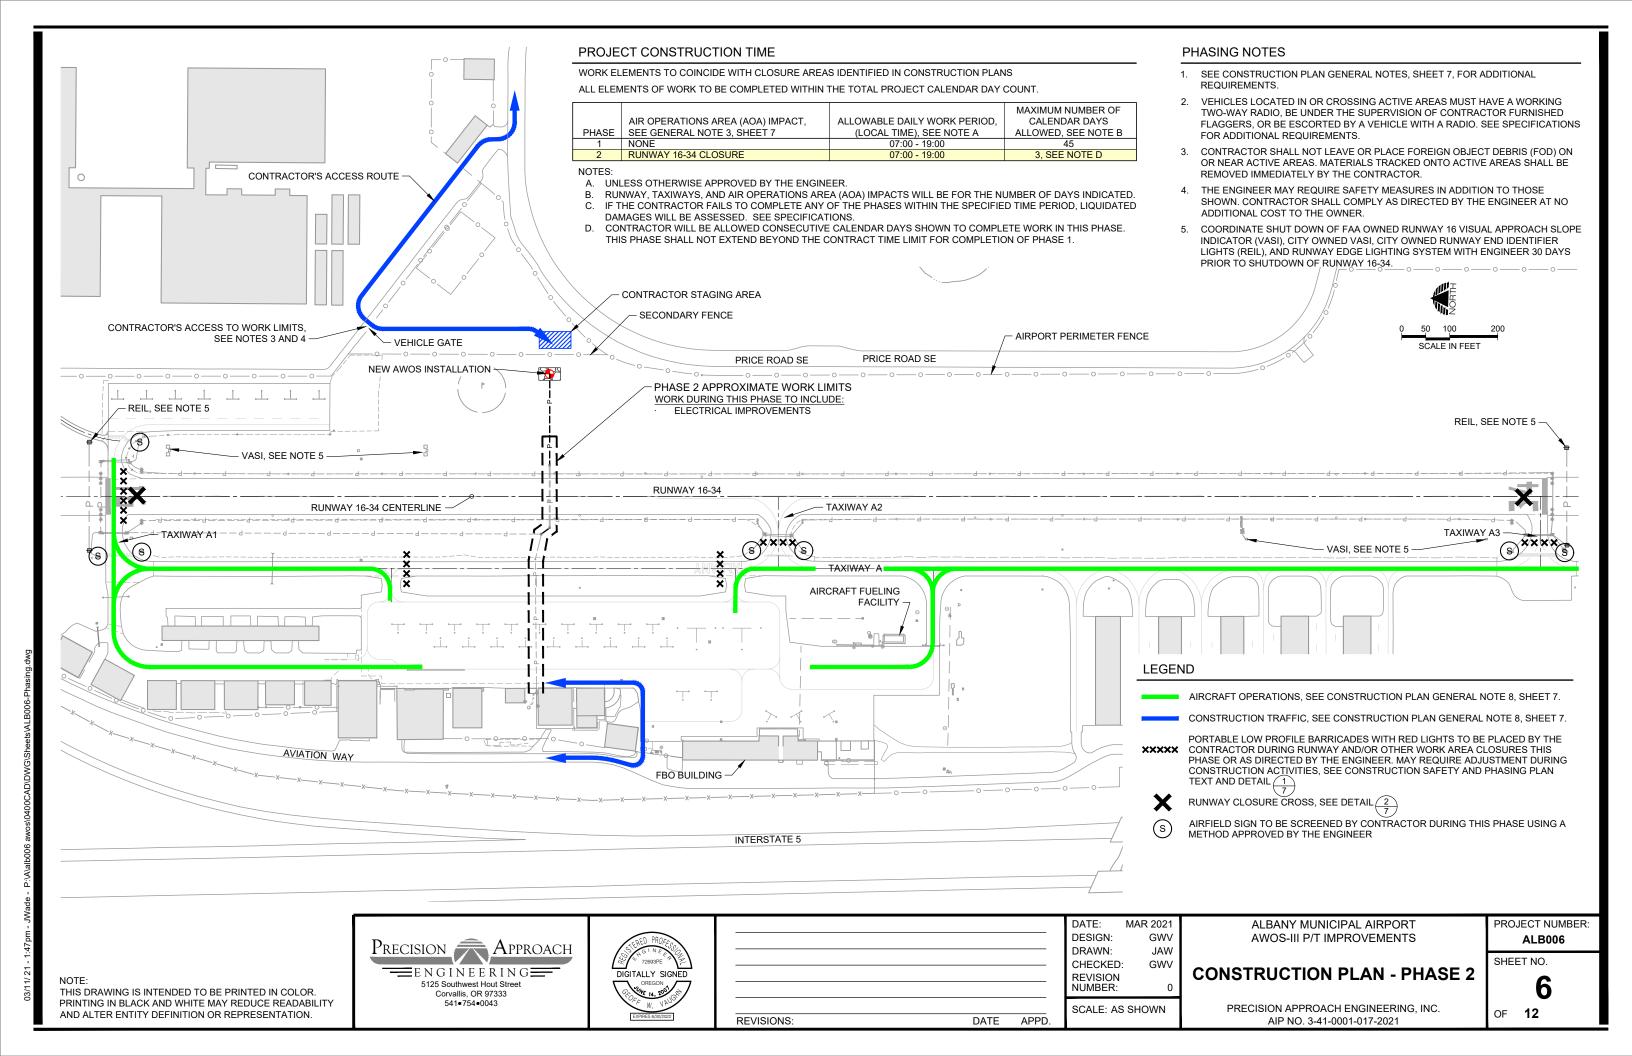
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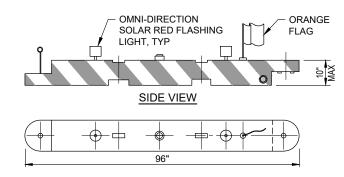
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OF **12**





- EXCEPT FOR CLOSURES NOTED, AIRPORT AND AIR OPERATIONS AREAS (AOAS) TO REMAIN OPEN TO AIRCRAFT OPERATIONS DURING ENTIRE COURSE OF WORK. SEE SPECIFICATIONS AND CONSTRUCTION SAFETY AND PHASING PLAN (CSPP) TEXT FOR ADDITIONAL REQUIREMENTS. CONTRACTOR SHALL COORDINATE WORK TO ASSURE MINIMUM INCONVENIENCE TO AIRPORT OPERATIONS. IN ALL CIRCUMSTANCES SAFETY SHALL TAKE PRECEDENCE.
- 2. AIRCRAFT ACCESS TO THE APRON AREAS AND HANGARS TO BE MAINTAINED AT ALL TIMES.
- WORK WITHIN THE RUNWAY OBSTACLE FREE ZONE (ROFZ) OR TAXIWAY OBJECT FREE AREA (TOFA) WILL REQUIRE CLOSURE OF IMPACTED RUNWAY OR TAXIWAY. SEE AIRFIELD CRITICAL AREAS DRAWING FOR LIMITS. SEE CSPP TEXT FOR ADDITIONAL REQUIREMENTS.
- 4. THE CONTRACTOR SHALL PROVIDE SUFFICIENT LEAD TIME FOR REQUIRED NOTIFICATIONS WITH PROJECT STAKEHOLDERS AND THE FEDERAL AVIATION ADMINISTRATION. THIS WILL REQUIRE SUBMITTAL OF A PRELIMINARY SCHEDULE TO INCLUDE START DATES FOR INDIVIDUAL PHASES AND DATES FOR AIRPORT FACILITIES IMPACTS WITHIN 10 CALENDAR DAYS AFTER NOTICE OF CONTRACT AWARD, A REVISED "CONSTRUCTION SCHEDULE" WILL BE PREPARED IN CONJUNCTION WITH THE PRE-CONSTRUCTION MEETING. THE CONTRACTOR SHALL NOTIFY THE OWNER WITH REQUESTS FOR NOTICES TO AIRMEN (NOTAMS) 48 HOURS PRIOR TO IMPLEMENTATION. CONTRACTOR SHALL COORDINATE WITH ENGINEER FOR CONSTRUCTION RELATED AOA CLOSURES. CLOSURES ARE SUBJECT TO APPROVAL BY THE OWNER. SEE CSPP TEXT FOR ADDITIONAL REQUIREMENTS.
- CONTRACTOR SHALL DELINEATE LOCATION OF RUNWAY OBJECT FREE AREA (ROFA) AND TOFA AT TRAFFIC ACCESS POINTS, AND PROVIDE OTHER FIELD DELINEATION TO SEPARATE CONSTRUCTION ACTIVITIES FROM AIRPORT OPERATIONS AS DIRECTED BY THE ENGINEER. DELINEATION WITHIN THE ROFA AND TOFA SHALL BE LOW PROFILE AND SHALL NOT PRESENT A HAZARD TO AIRCRAFT. CONES. STAKES, OR OTHER METHODS AS APPROVED BY THE ENGINEER MAY BE USED OUTSIDE THE ROFA AND
- BARRICADES, LIGHTS, AND OTHER CONSTRUCTION CONTROL DEVICES FURNISHED, PLACED, AND MAINTAINED BY THE CONTRACTOR SHALL BE PROVIDED AT VARIOUS LOCATIONS, AS NECESSARY TO ADEQUATELY SEPARATE CONSTRUCTION ACTIVITIES FROM THE AGA, BARRICADES SHOWN ON THE DRAWINGS ARE FOR REFERENCE AND THE NUMBER AND LOCATION OF BARRICADES MAY CHANGE TO MEET SAFETY REQUIREMENTS.
- PRIOR TO REOPENING A CLOSED RUNWAY OR TAXIWAY FOR OPERATIONS THE CONTRACTOR SHALL PROVIDE ADEQUATE TIME FOR THE ENGINEER OR OWNER TO INSPECT FOR CLEANLINESS AND CONFORMANCE TO REGULATIONS INCLUDING GRADING REQUIREMENTS OF THE RUNWAY SAFETY AREA (RSA) OR TAXIWAY SAFETY AREA (TSA). THE TIME NEEDED FOR INSPECTION AND POSSIBLE NECESSARY CORRECTIVE ACTION SHALL BE INCLUDED WITHIN THE ALLOWED CLOSURE PERIOD.
- 8. WORK AREAS SHOWN IN PHASING PLANS ARE APPROXIMATE. SEE APPROPRIATE DRAWINGS FOR SPECIFIC WORK LIMITS, CONTRACTOR SHALL COORDINATE ALL WORK ELEMENTS COMPATIBLE WITH INTENDED PHASE UNLESS OTHERWISE APPROVED BY THE ENGINEER OR OWNER. AIRCRAFT OPERATIONS ROUTES SHOWN ARE APPROXIMATE AND ARE NOT LIMITED TO LOCATIONS SHOWN CONTRACTOR SHALL REMAIN CLEAR OF AIRCRAFT OPERATIONS AT ALL TIMES.
- 9. CONTRACTOR SHALL NOT BLOCK VEHICLE ACCESS ROADS OR GATES AT ANY TIME.
- 10. LOCATION OF THE CONTRACTOR'S STAGING AREAS ARE APPROXIMATE. VERIFY LIMITS AND LOCATIONS WITH ENGINEER PRIOR TO MOBILIZATION.
- 11. ALL VEHICLES NOT ESSENTIAL FOR CONSTRUCTION, INCLUDING CONTRACTOR-EMPLOYEE VEHICLES SHALL REMAIN OUTSIDE OF AIR OPERATIONS AREA. PARKING SHALL BE CONFINED TO THE CONTRACTOR'S STAGING AREA
- 12. ALL PORTIONS OF WORK NOT COVERED BY PAYMENT UNDER A SPECIFIC BID ITEM OR LISTED AS INCIDENTAL TO A BID ITEM SHALL BE CONSIDERED INCIDENTAL TO THE MOBILIZATION BID ITEM.
- 13. THE CONTRACTOR SHALL USE AND MONITOR THE AIRPORT'S COMMON TRAFFIC ADVISORY FREQUENCY (CTAF), 122,725 MHZ, SEE CSPP TEXT FOR ADDITIONAL REQUIREMENTS.
- 14. CONTRACTOR SHALL SCREEN EXISTING GUIDANCE SIGNS LEADING TO CLOSED AREAS USING METHODS APPROVED BY ENGINEER. CONTRACTOR SHALL SUBMIT GUIDANCE SIGN SCREENING PLAN FOR ENGINEER REVIEW AND APPROVAL PRIOR TO IMPLEMENTATION.
- 15. ALL CONSTRUCTION EQUIPMENT MUST BE MARKED WITH A 3 FEET BY 3 FEET ORANGE AND WHITE CHECKERED FLAG AND/OR AMBER BEACON. ALL CONSTRUCTION VEHICLES MUST BE CLEARLY MARKED WITH THE COMPANY LOGO AT ALL TIMES.
- 16. AIRFIELD LIGHTING TO BE OPERATIONAL AT ALL TIMES FROM SUNSET TO SUNRISE FOR AREAS OPEN TO AIRCRAFT OPERATIONS.

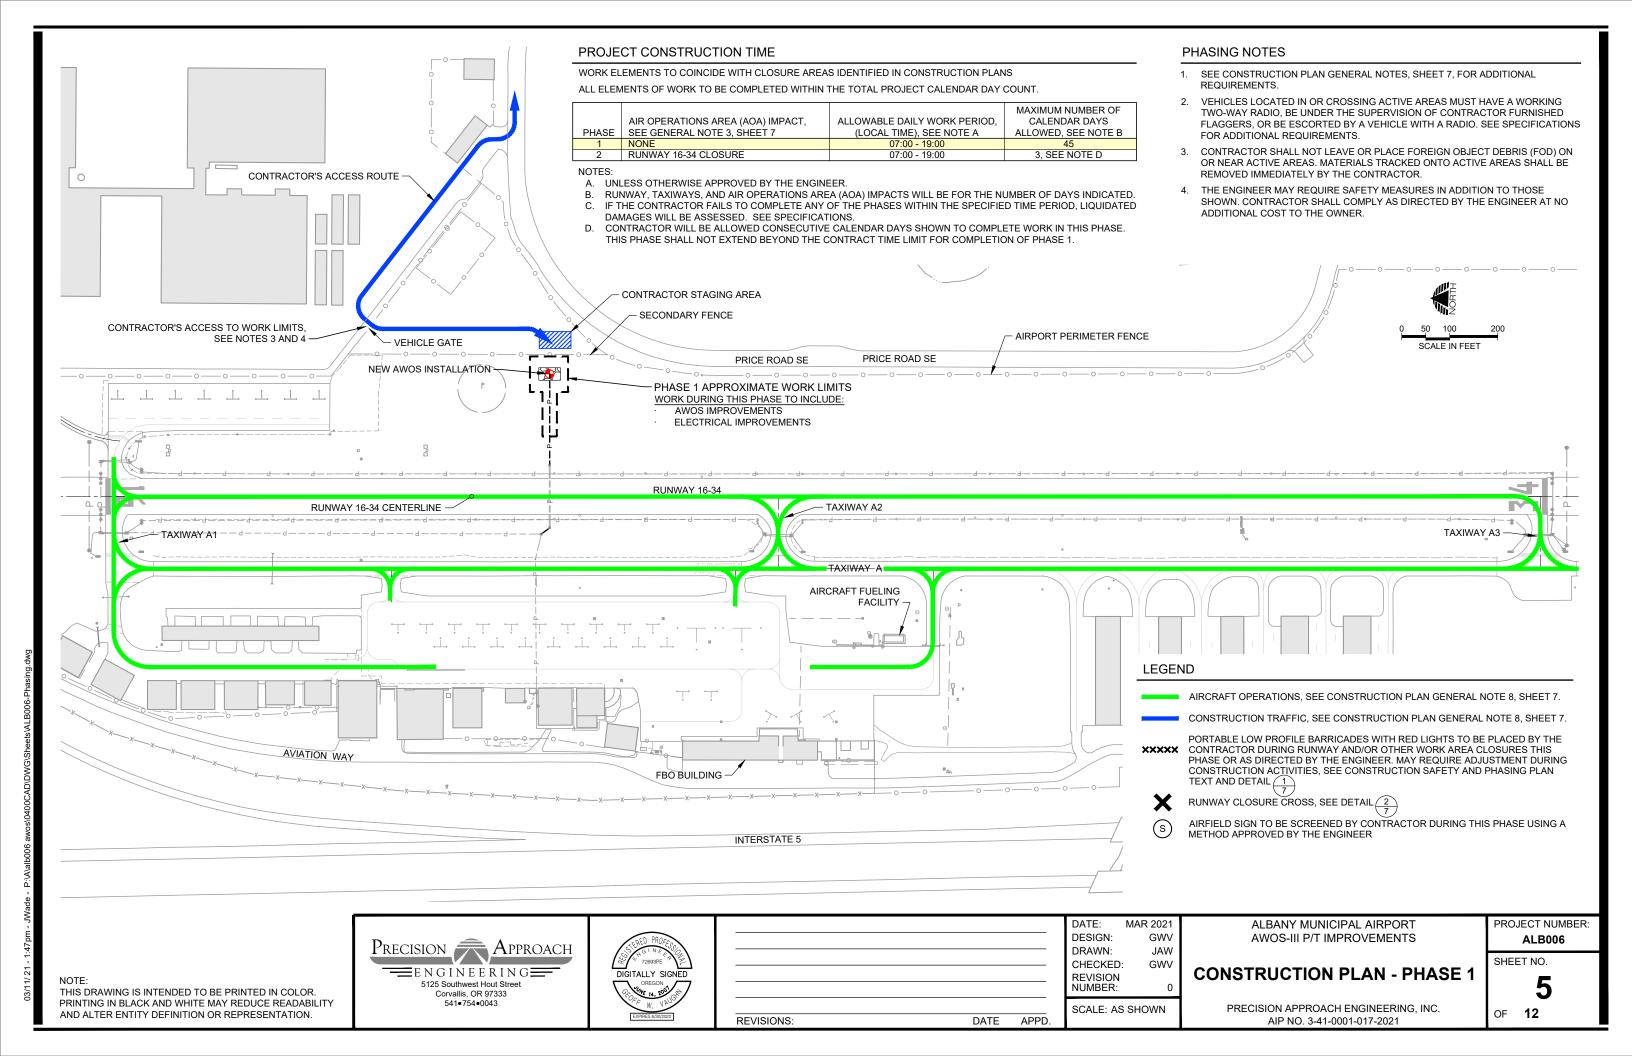

TOP VIEW


NOTES

- 1 PROVIDE BARRICADE CAPABI E OF BEING FILLED WITH WATER OR SAND. IF ALTERNATE METHOD OF ANCHORING IS USED IT SHALL NOT CAUSE DAMAGE TO PAVEMENT.
- 2. BARRICADE TO BE CAPABLE OF BEING DEPLOYED BY ONE PERSON WHEN EMPTY.
- 3. CONTRACTOR SHALL MAINTAIN ALL LIGHTS IN WORKING ORDER FOR THE DURATION OF THE PROJECT. CONTRACTOR SHALL REPLACE FLAGS AS NECESSARY OR AS DIRECTED BY THE ENGINEER DUE TO DETERIORATION.
- 4. BARRICADES TO BE PROVIDED BY THE CONTRACTOR ARE INCIDENTAL TO THE MOBILIZATION BID ITEM AND ARE PROPERTY OF THE CONTRACTOR UPON COMPLETION
- 5. NO CONSTRUCTION SHALL BEGIN UNTIL BARRICADES HAVE BEEN PLACED AND APPROVED BY THE ENGINEER.



RUNWAY CLOSURE CROSS NOTES:

- 1. TWO FAA APPROVED FABRIC STYLE TEMPORARY CLOSURE CROSSES SHALL BE PROVIDED BY THE CONTRACTOR. THE CONTRACTOR SHALL BE RESPONSIBLE FOR PLACEMENT AND MAINTAINING THE CONDITION OF THE CROSSES. CROSSES MUST BE PROPERLY CONFIGURED AND SECURED TO PREVENT MOVEMENT BY PROP WASH, JET BLAST, OR OTHER WIND CURRENTS AS REQUIRED OR DIRECTED BY THE RPR. SEE SPECIFICATIONS FOR ADDITIONAL INFORMATION AND REQUIREMENTS
- 2. PLACE CLOSURE CROSSES AT THE RUNWAY NUMERALS OR AS INDICATED ON THE DRAWINGS ANYTIME RUNWAY 16-34 IS CLOSED TO OPERATIONS.
- 3. CLOSURE CROSSES TO BE PROVIDED BY THE CONTRACTOR ARE INCIDENTAL TO THE MOBILIZATION BID ITEM AND ARE PROPERTY OF THE CONTRACTOR UPON COMPLETION OF THE

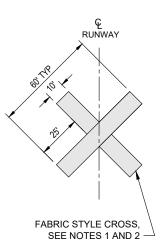

RUNWAY CLOSURE CROSS DETAIL NTS





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ALBANY MUNICIPAL AIRPORT AWOS-III P/T IMPROVEMENTS


CONSTRUCTION PLAN GENERAL NOTES AND DETAILS

PRECISION APPROACH ENGINEERING, INC. AIP NO. 3-41-0001-017-2021


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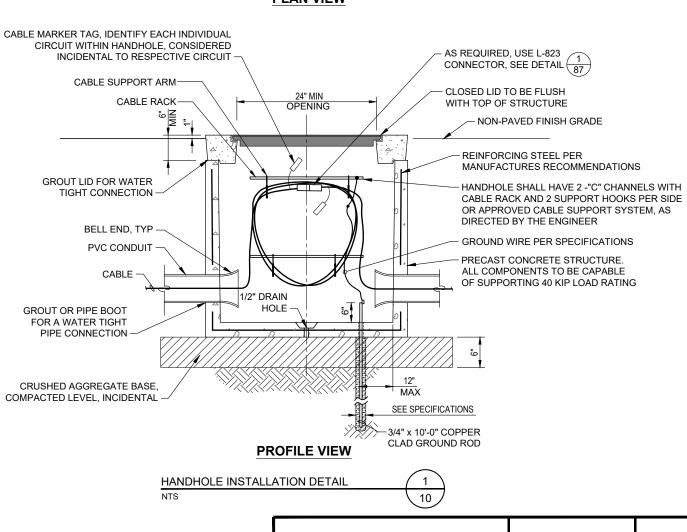
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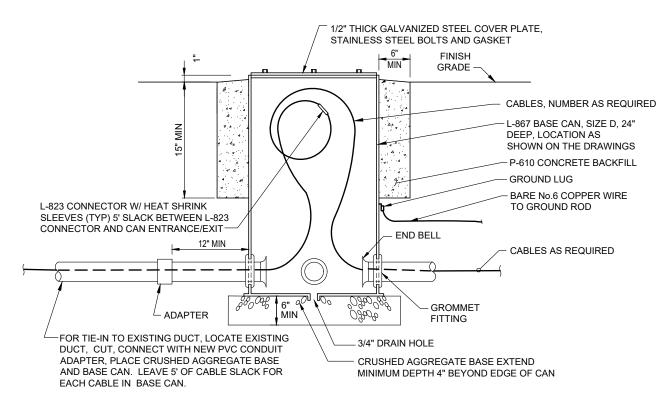




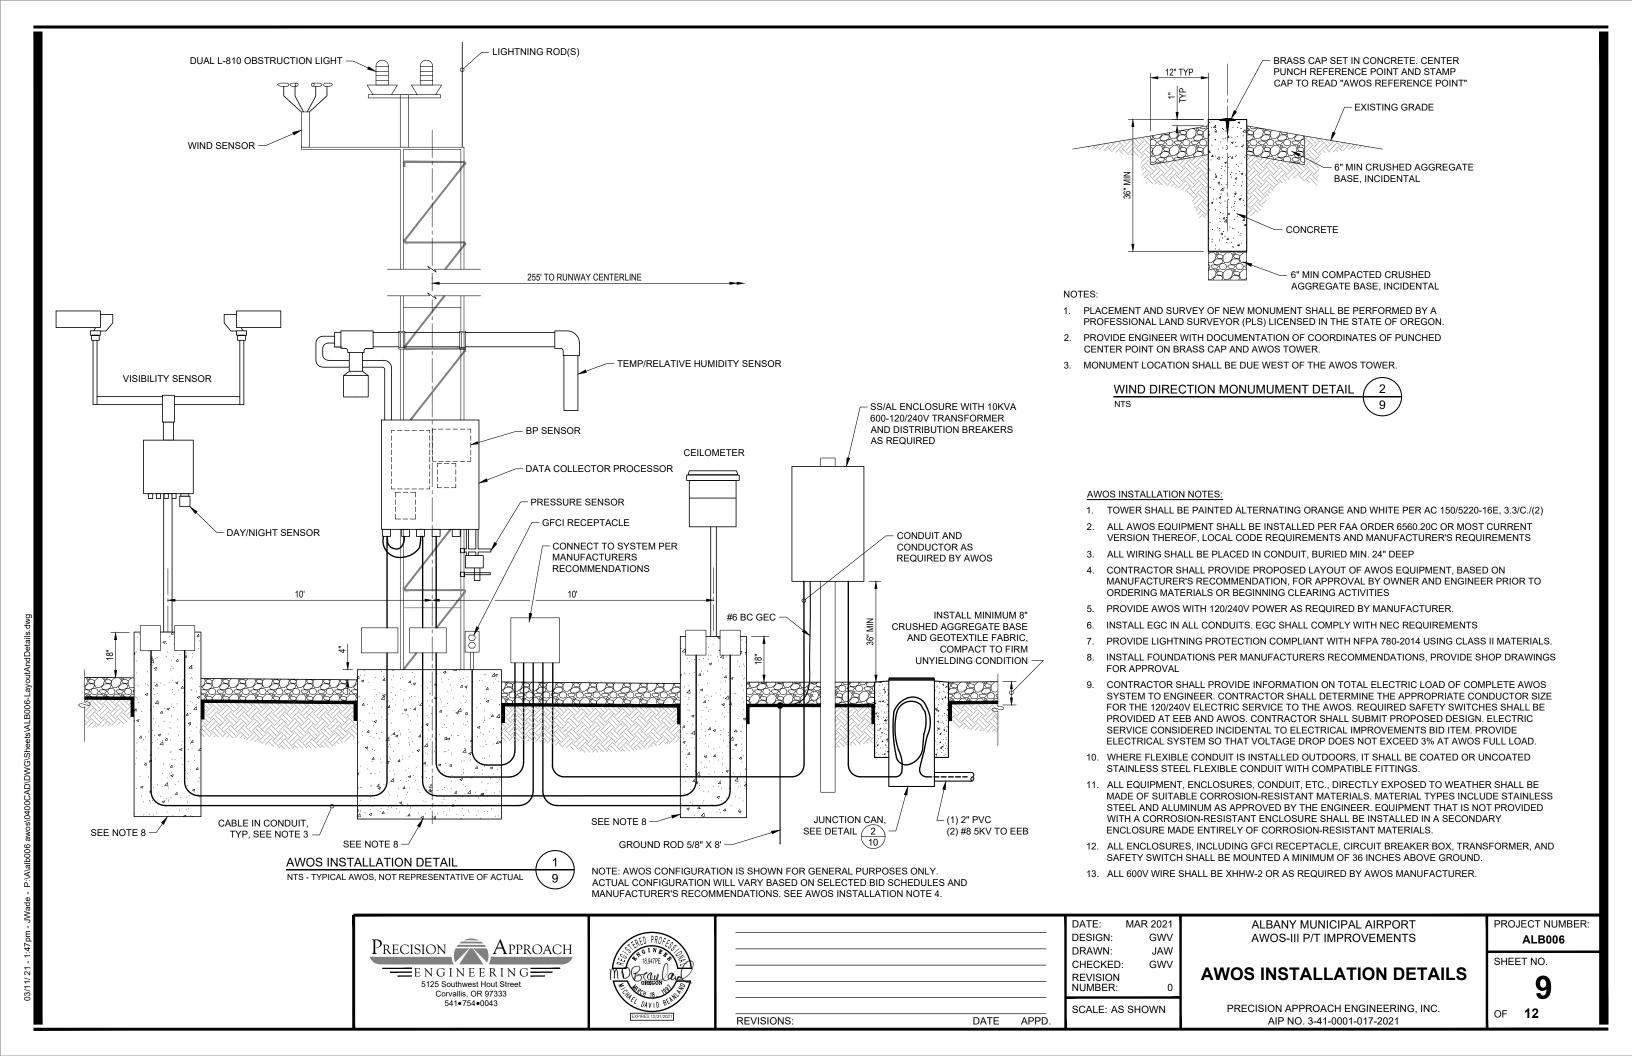

- 1. PROVIDE CABLE SUPPORT LEVEL, MINIMUM, WITH SPLICE
- SEE NOTES 2 2. NUMBER AND LOCATION OF CONDUITS AND CABLE WILL VARY FOR EACH HANDHOLE. SEE PLAN SHEET.
 - 3. AS APPLICABLE SEPARATE HIGH AND LOW VOLTAGE CABLES TO OPPOSING WALLS OF HANDHOLE OR AS DIRECTED BY THE ENGINEER.
 - 4. WHERE CONNECTIONS ARE MADE TO EXISTING CIRCUITS ENSURE SPLICE IS MADE IN HANDHOLE WITH ENOUGH SLACK TO PULL A SPLICE A MINIMUM 18" ABOVE
 - 5. CONTRACTOR TO PROVIDE SHOP DRAWINGS FOR ENGINEERS APPROVAL PRIOR TO ORDERING STRUCTURES.
 - 6. LID TO HINGE OPEN AWAY FROM RUNWAY.
 - 7. NEW HANDHOLE LOCATION AS DIRECTED BY ENGINEER. EXTENSION OF EXISTING DUCT BANK CONDUITS TO NEW HANDHOLE PAID FOR BY RESPECTIVE SIZE CONDUIT BID



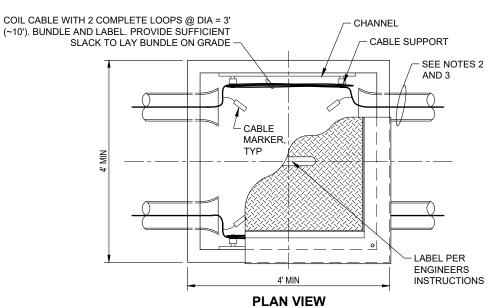

JUNCTION CAN INSTALLATION DETAIL





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ELECTRICAL DETAILS

ALBANY MUNICIPAL AIRPORT


AWOS-III P/T IMPROVEMENTS

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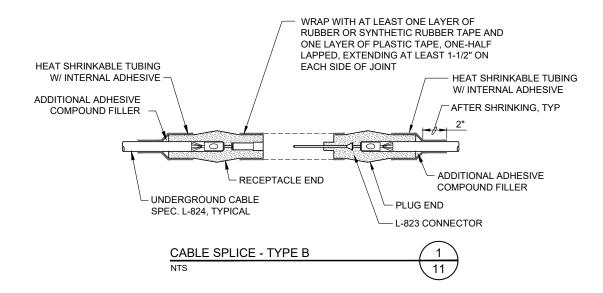
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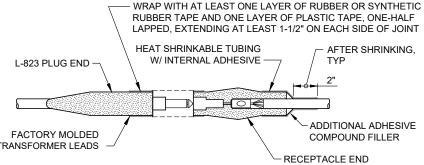
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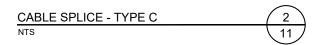


NOTE: SPLICES TO BE USED AT JUNCTION OF HOMERUN WITH LOOP CIRCUIT



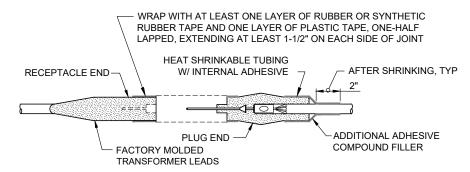

2. INSIDE DIAMETER OF CONNECTOR SHALL PROPERLY MATCH THE OUTSIDE DIAMETER OF CABLE.









DATE: MAR 2021 DESIGN: GWV DRAWN: JAW CHECKED: GWV REVISION NUMBER:

TRENCH BACKFILL-

FINISH GRADE

CONDUIT, AS SHOWN ON PLANS

BEDDING MATERIAL

NTS

NON-PAVED TRENCH DETAIL

SCALE: AS SHOWN

ALBANY MUNICIPAL AIRPORT AWOS-III P/T IMPROVEMENTS

TRENCH WARNING TAPE

ELECTRICAL DETAILS

SHEET NO.

OF **12**

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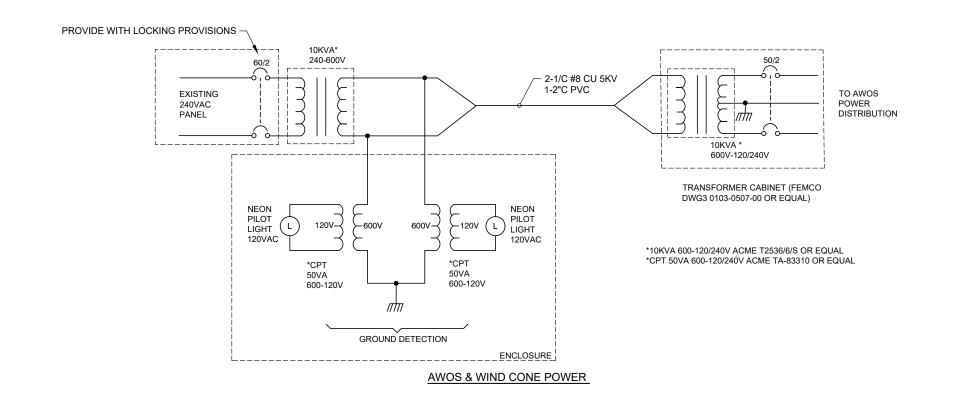
ALB006

PRECISION APPROACH ENGINEERING, INC. AIP NO. 3-41-0001-017-2021

FACTORY MOLDED TRANSFORMER LEADS NOTES: 1. FOR SPLICES AT LIGHT FIXTURES AND SIGNS.

| | | | Albany A | irport EE | B Electric | cal Panel | | | |
|----------|------------------|-------|----------|-----------|------------|-----------|-------|---------------|----------|
| CT NO | LOAD | СВ | LOAD | L1 | L2 | LOAD | СВ | LOAD | CT NO |
| 1 | J Box NE Corner | 20 | 10 | 15 | | 5 | 20 | Receptacles | 2 |
| 3 | " | 20 | 10 | | 20 | 10 | 20 | Beacon | 4 |
| 5 | Vent Fan, Lights | 20 | 5 | 10 | | 5 | 20 | Wind Cone | 6 |
| 7 | VASI | 20 | 16 | | 21 | 5 | 20 | " | 8 |
| 9 | " | 20 | 16 | 61 | | 45 | 70 | MIRL | 10 |
| 11 | North REIL | 20 | 5 | | 50 | 45 | 70 | " | 12 |
| 13 | " | 20 | 5 | 6 | | 1 | 15 | Control Power | 14 |
| 15 | AWOS (New) | 60 | 6 | | 16 | 10 | 30 | Gate Panel | 16 |
| 17 | " | 60 | 6 | 16 | | 10 | 30 | " | 18 |
| 19 | | Space | | | 0 | | Space | | 20 |
| 21 | | Space | | 0 | | | Space | | 22 |
| 23 | | Space | | | 0 | | Space | | 24 |
| 25 | | Space | | 0 | | | Space | | 26 |
| 27 | | Space | | | 0 | | Space | | 28 |
| 29 | | Space | | 0 | | | Space | | 30 |
| | | • | Total | 108 | 107 | | | | |

| AWOS Power | Watts |
|--------------------|-------|
| Radio | 10 |
| Wind Sensor | 0.5 |
| Wind Sensor Heater | 72 |
| Data Platform | 100 |
| Rain Guage Heater | 300 |
| Laser Ceileometer | 100 |
| Laser Heater | 500 |
| Visibility Sensor | 200 |
| Radio | 2 |
| TOTAL | 1285 |
| | • |







| | | | D, () L . | 100 01 202 1 |
|------------|------|-------|---------------------|--------------|
| | | | DESIGN: | GWV |
| | | | DRAWN: | JAW |
| | | | CHECKED | : GWV |
| | | | REVISION NUMBER: | C |
| | | | SCALE: AS | SHOWN |
| REVISIONS: | DATE | APPD. | | |

DATE: MAR 2021 DESIGN: GWV DRAWN: JAW CHECKED: GWV REVISION NUMBER:

ELECTRICAL DETAILS

ALBANY MUNICIPAL AIRPORT

AWOS-III P/T IMPROVEMENTS

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